




HDR Engineering, Inc. of the Carolinas N.C.B.E.L.S. License No. F-0116

101 N. 3rd Street, Suite 201 Wilmington, NC 28401-4034 910.398.9020

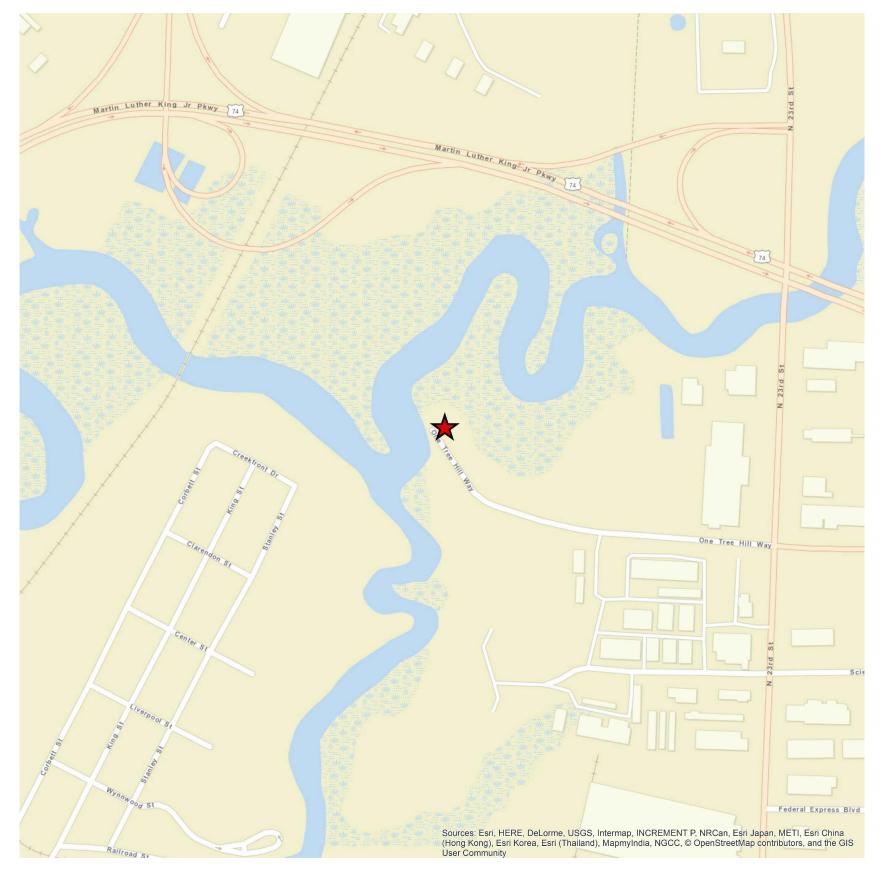

VICINITY MAP

Contract Drawings For


Pump Station #10 Replacement

ISSUED FOR CONSTRUCTION

NC DWI Project No. E-SRP-W-17-0029


HDR Project No. 000000010075083


Wilmington, NC February 2019

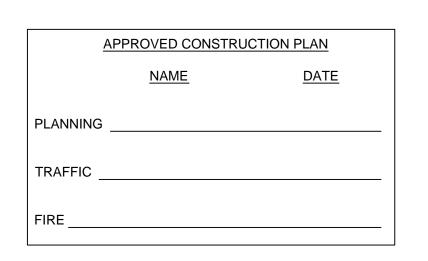





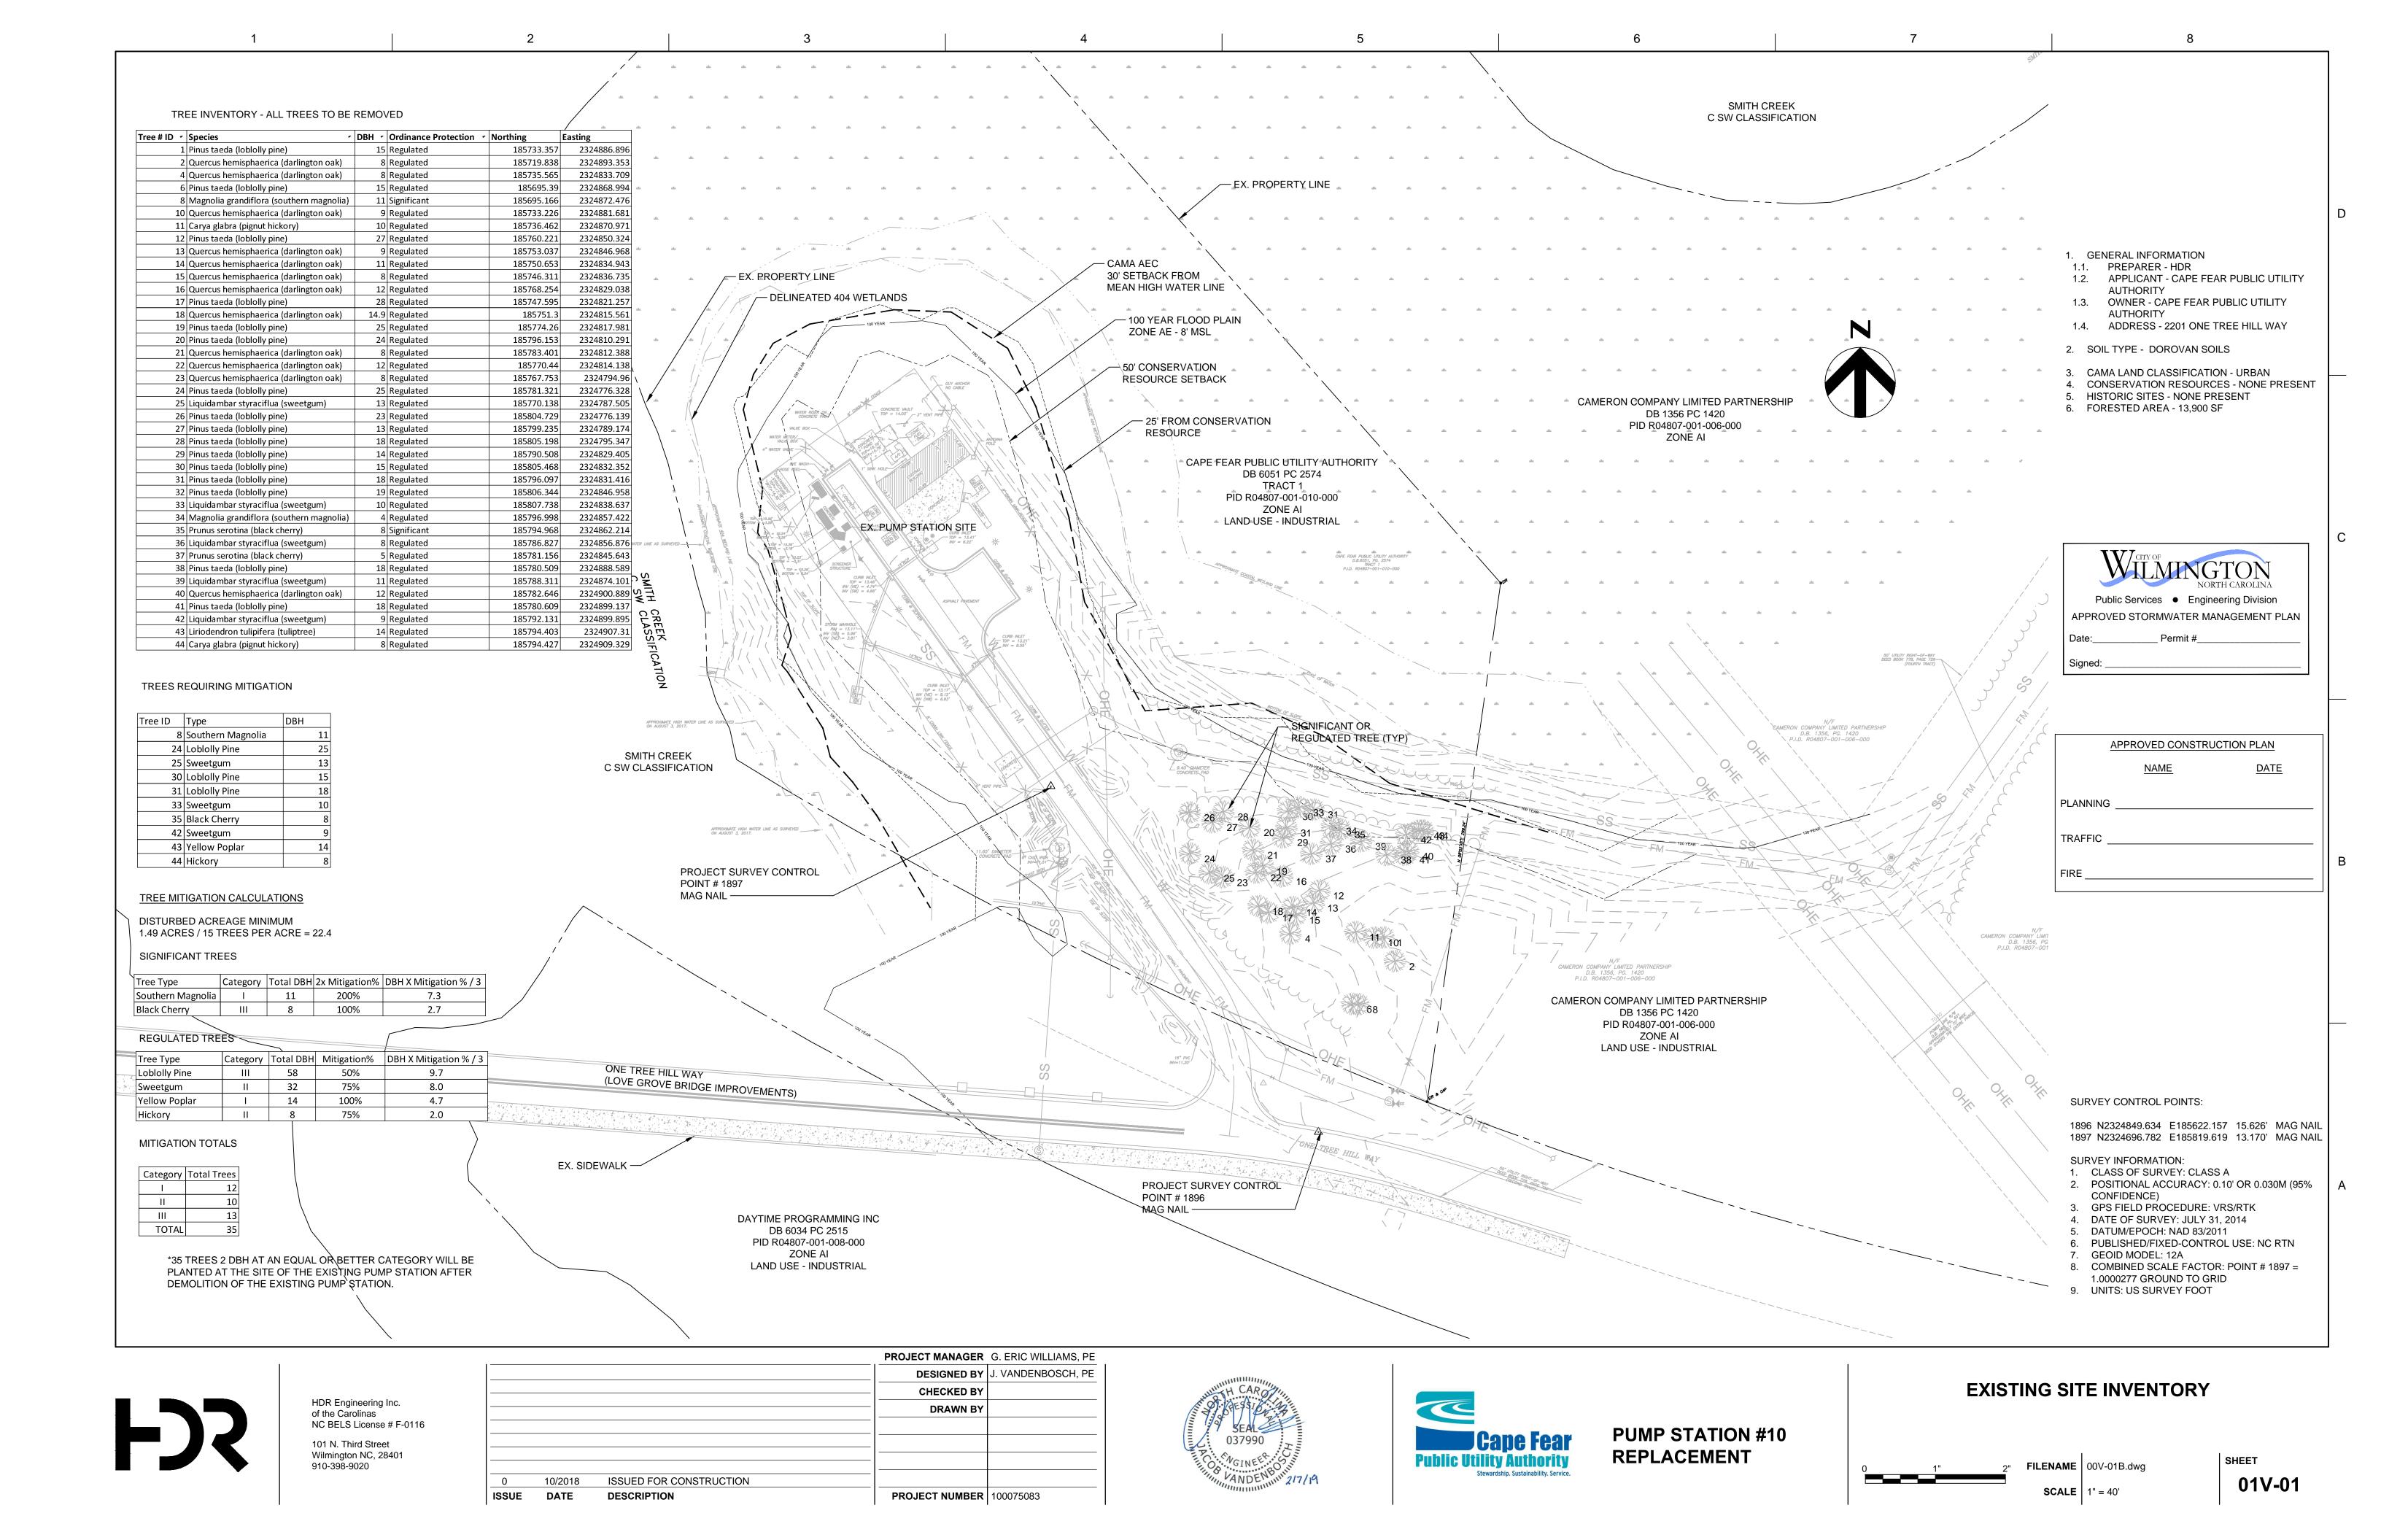

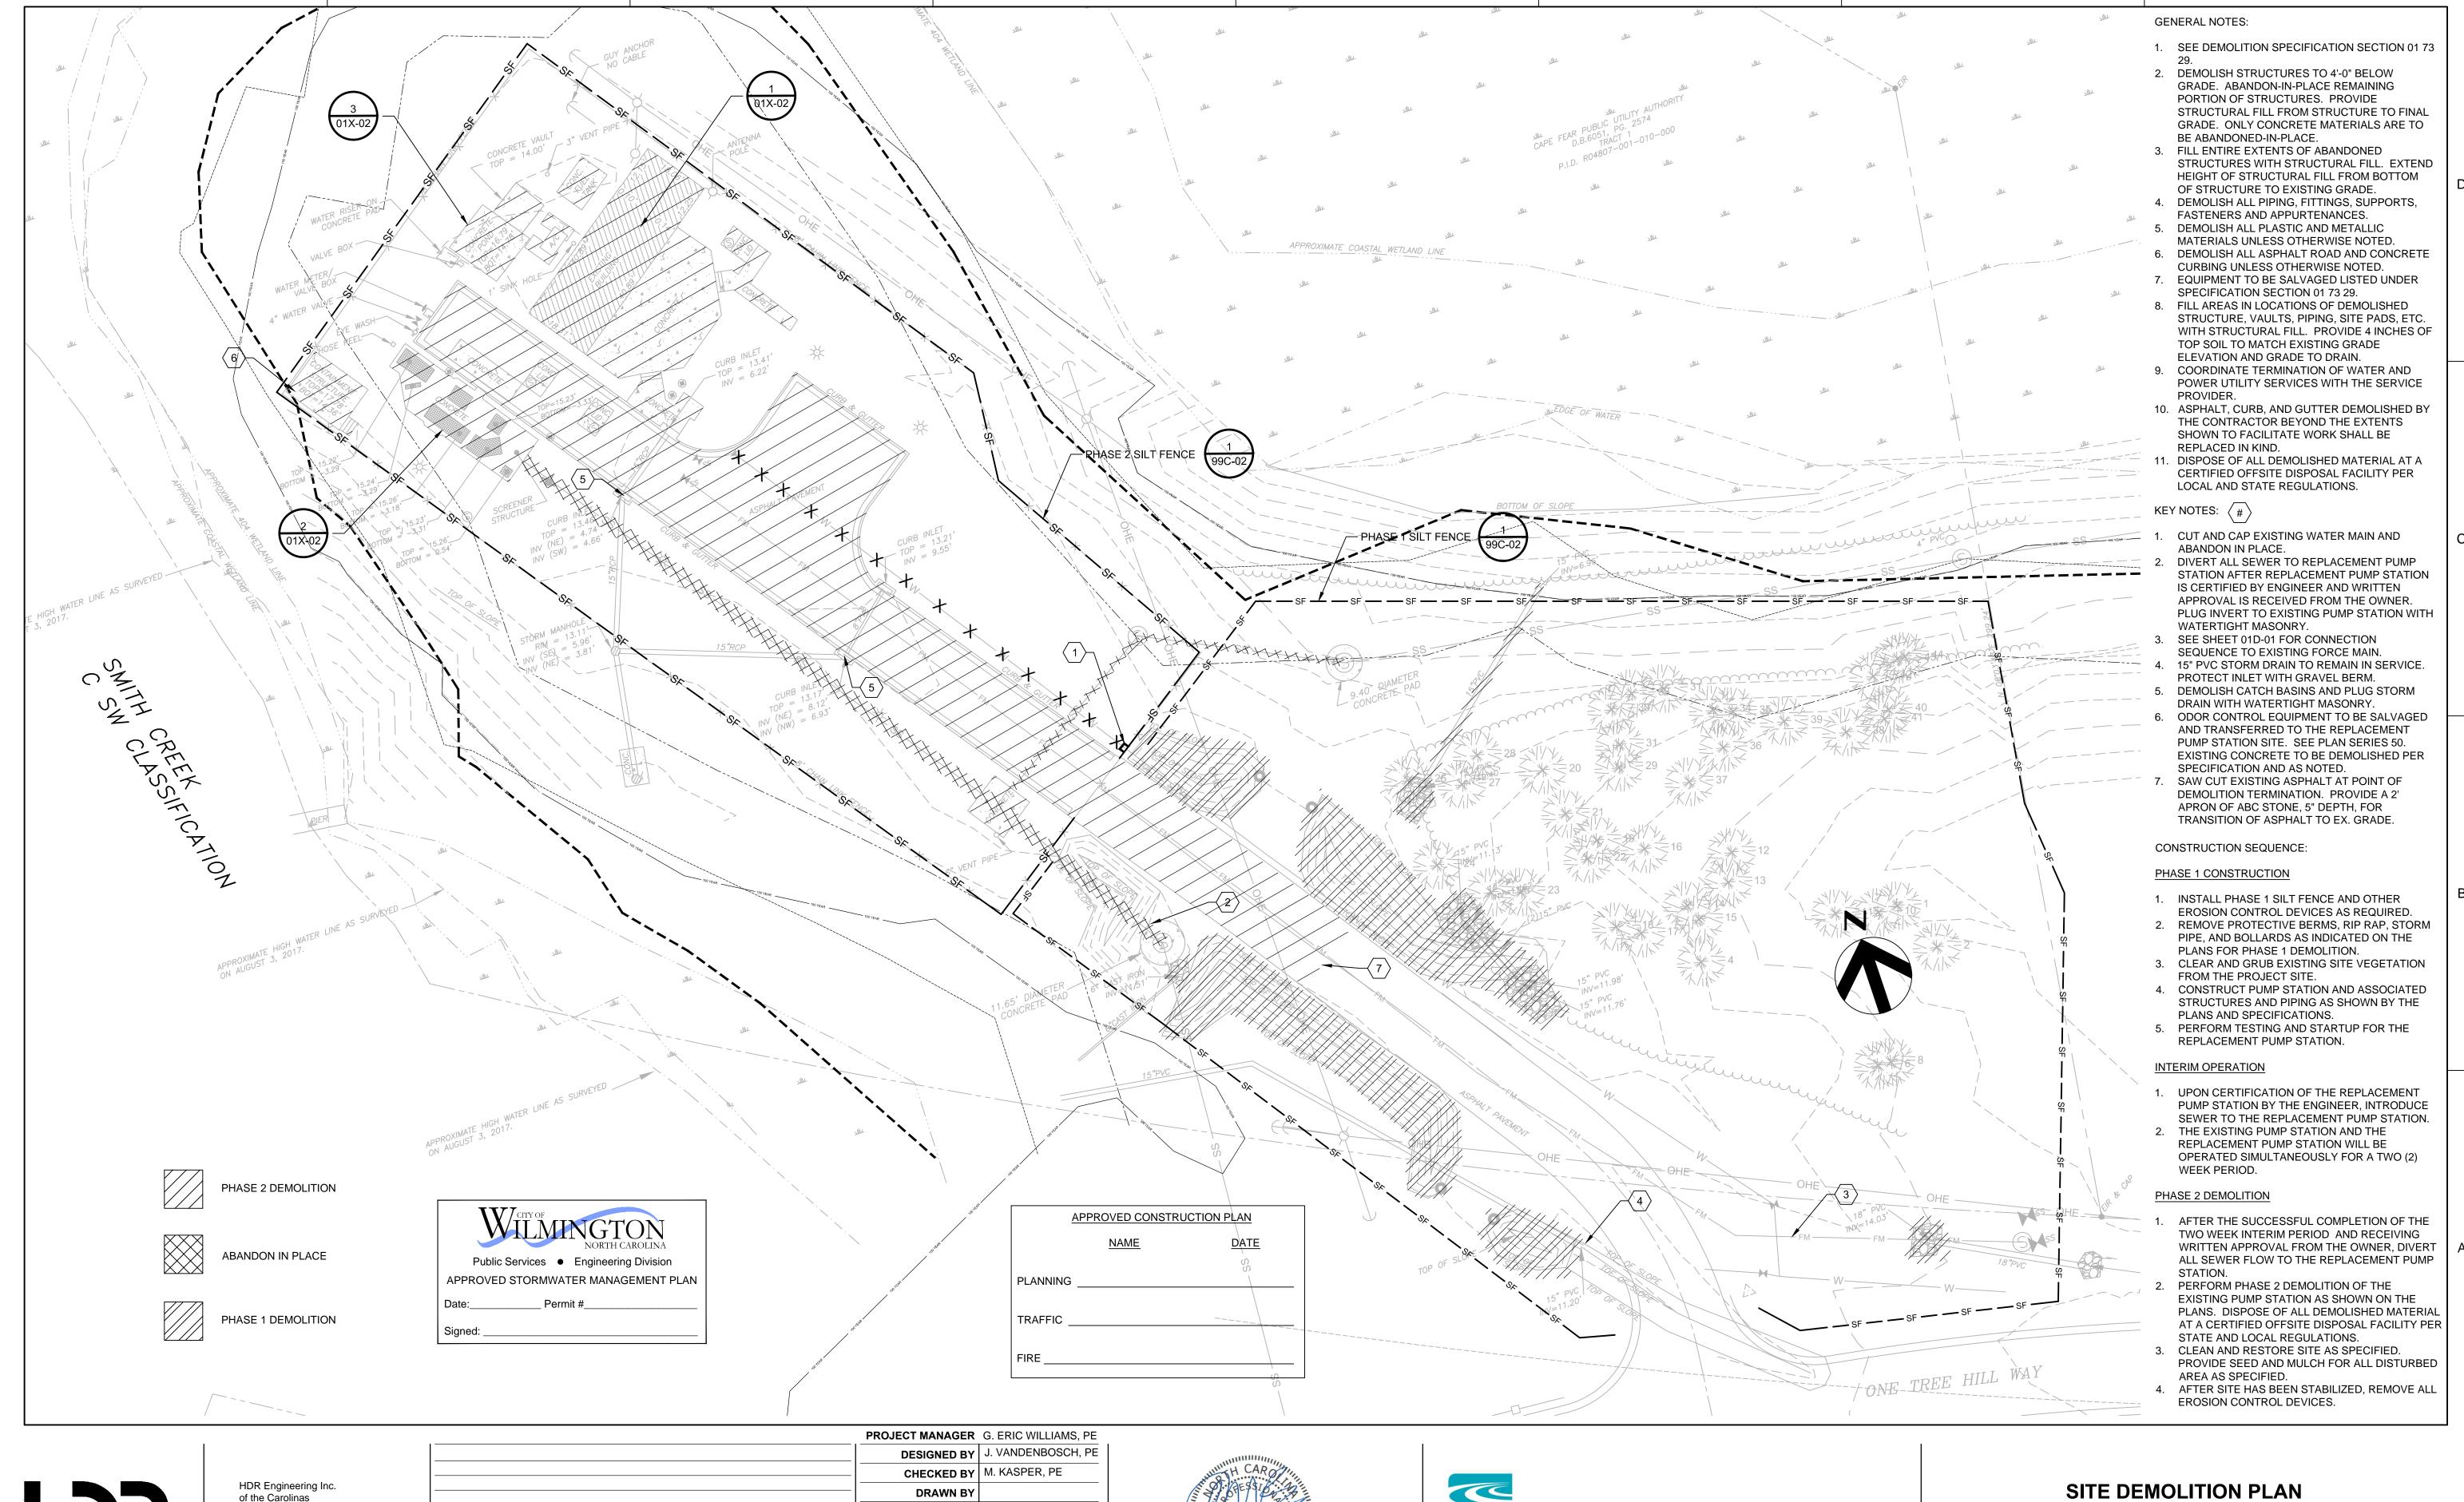



HDR Engineering Inc. of the Carolinas NC BELS License # F-0116 101 N. Third Street Wilmington NC, 28401 910-398-9020

ISSUE	DATE	DESCRIPTION	PROJECT NUMBER	100075083
0	10/2018	ISSUED FOR CONSTRUCTION		
			DRAWN BY	
			CHECKED BY	M. KASPER, PE
			DESIGNED BY	J. VANDENBOSCH, PE






PUMP STATION #10 REPLACEMENT



01X-01

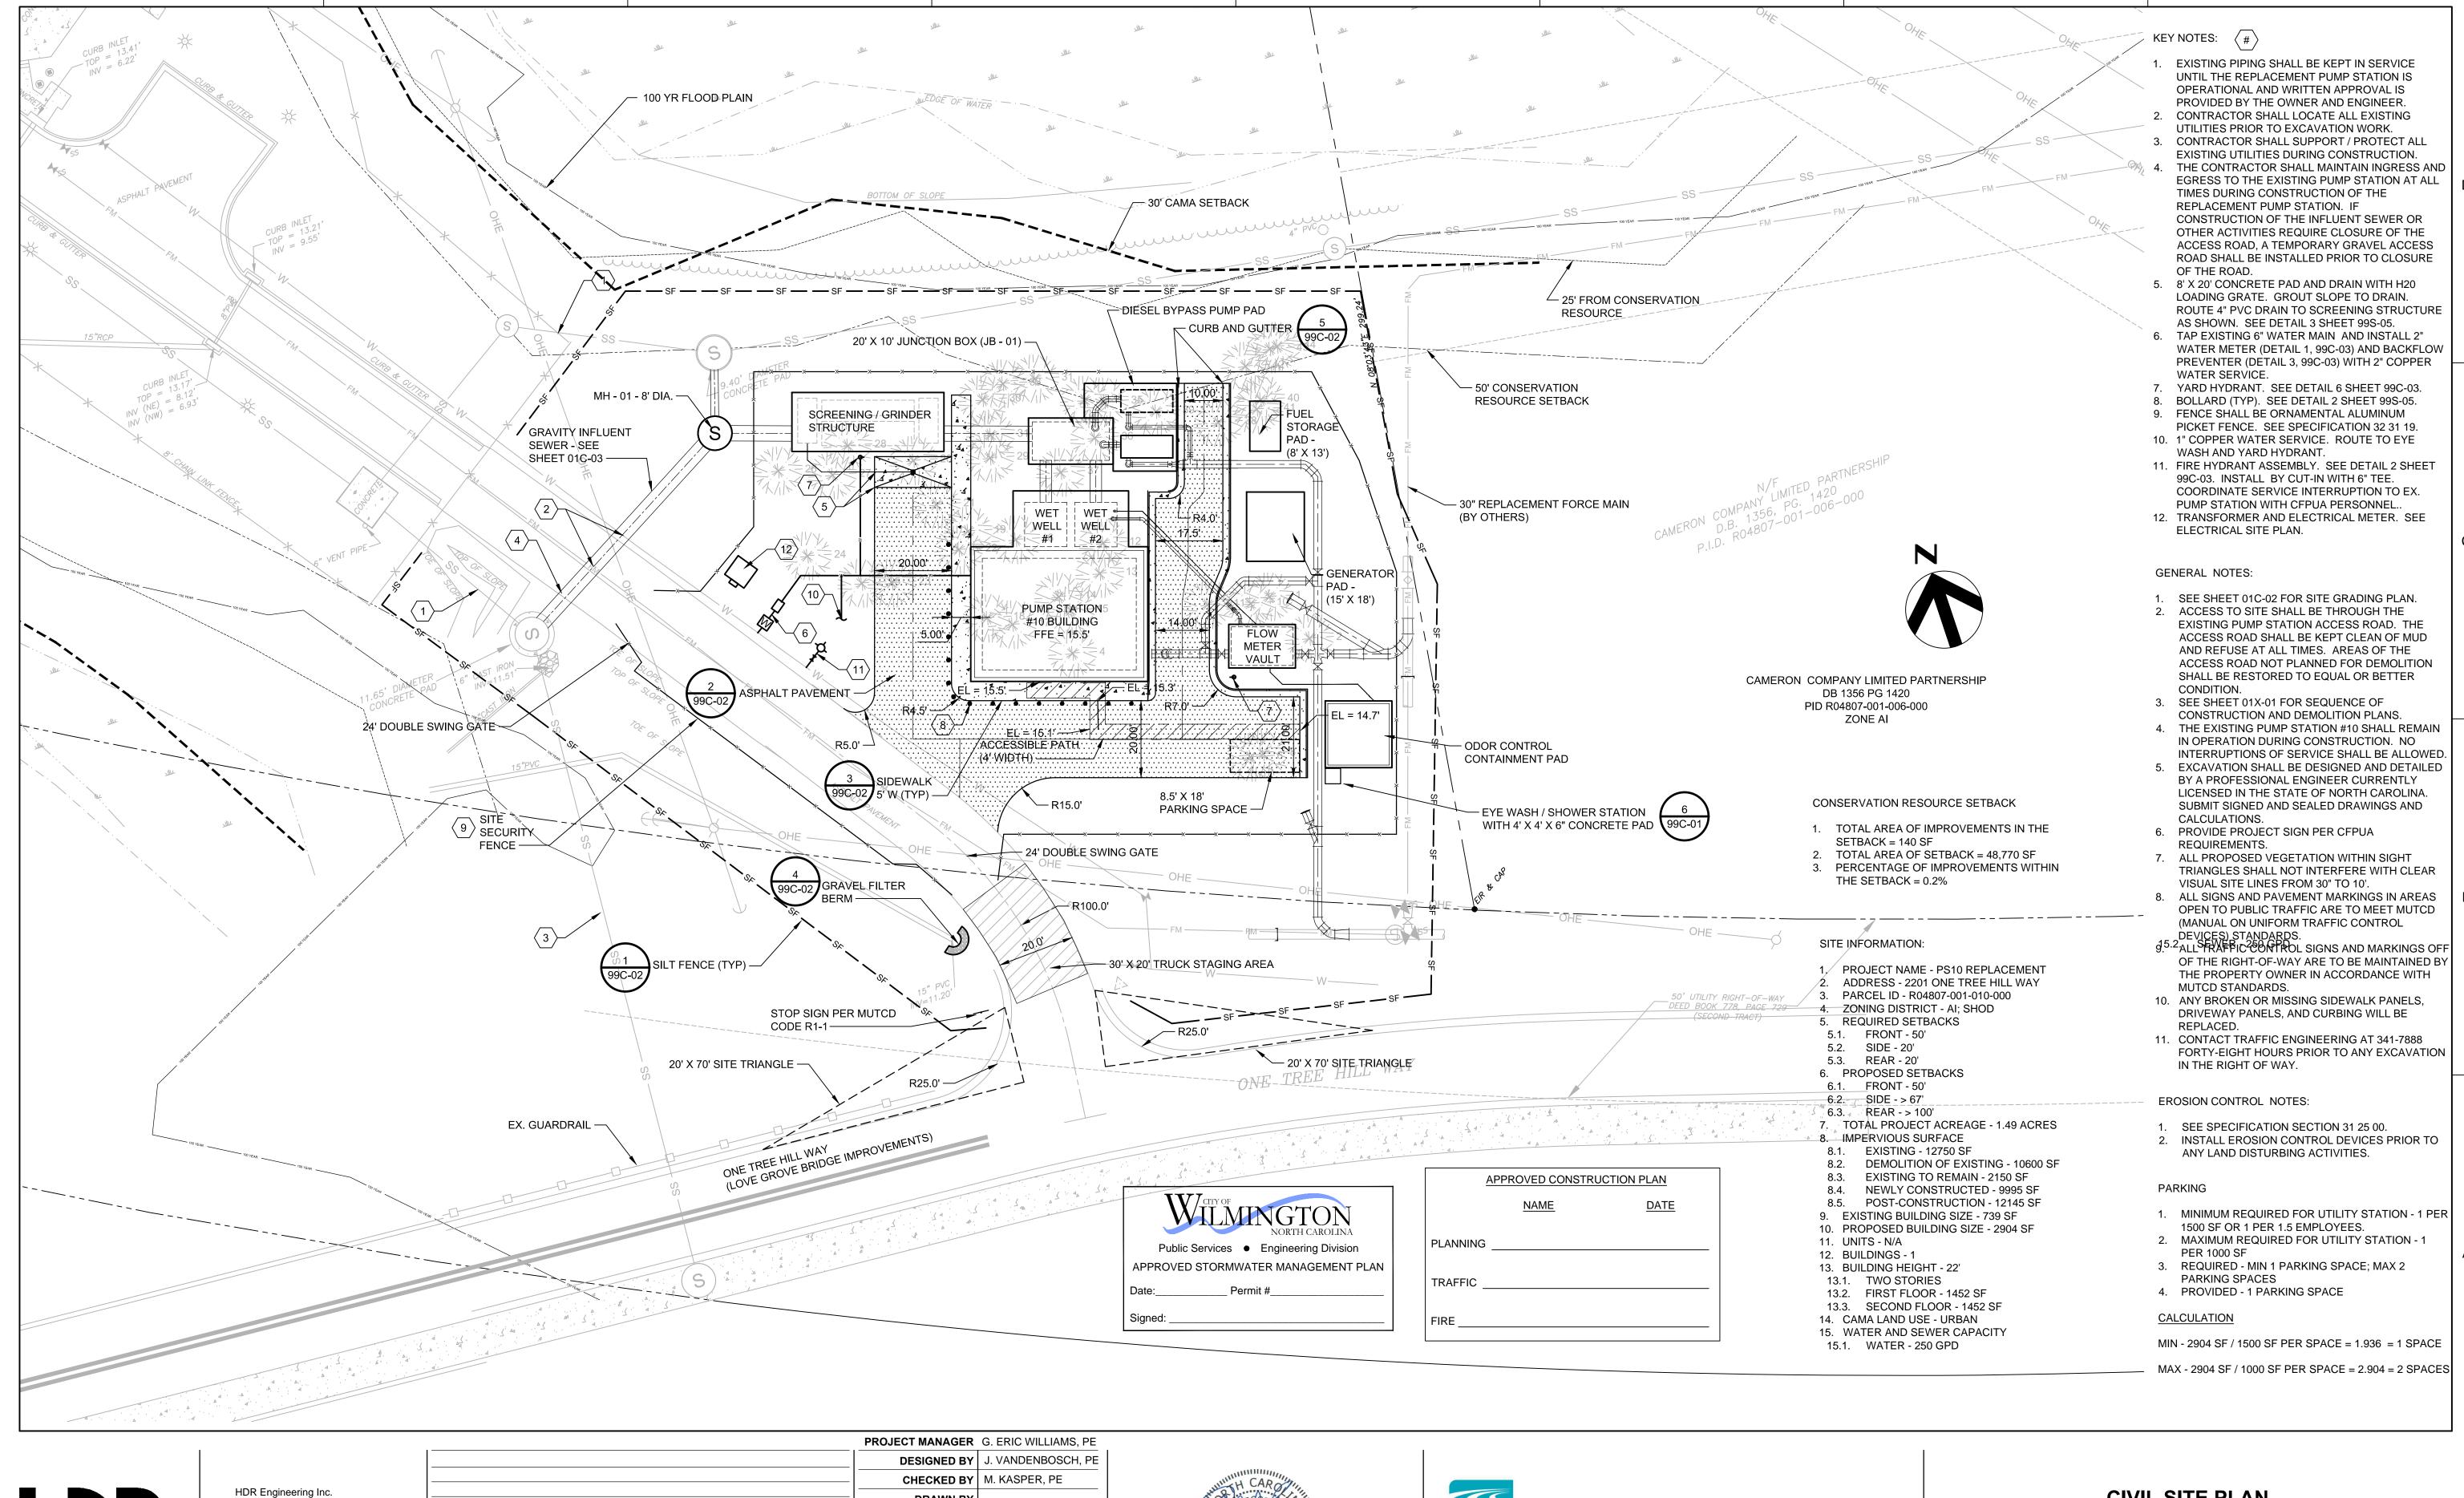



of the Carolinas

101 N. Third Street

910-398-9020

Wilmington NC, 28401

NC BELS License # F-0116


DRAWN BY ISSUED FOR CONSTRUCTION DATE DESCRIPTION PROJECT NUMBER | 100075083





PUMP STATION #10 REPLACEMENT


CIVIL SITE PLAN

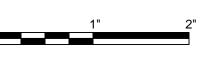

FILENAME 00C-01B.dwg

SCALE 1" = 20'

SHEET 01C-01

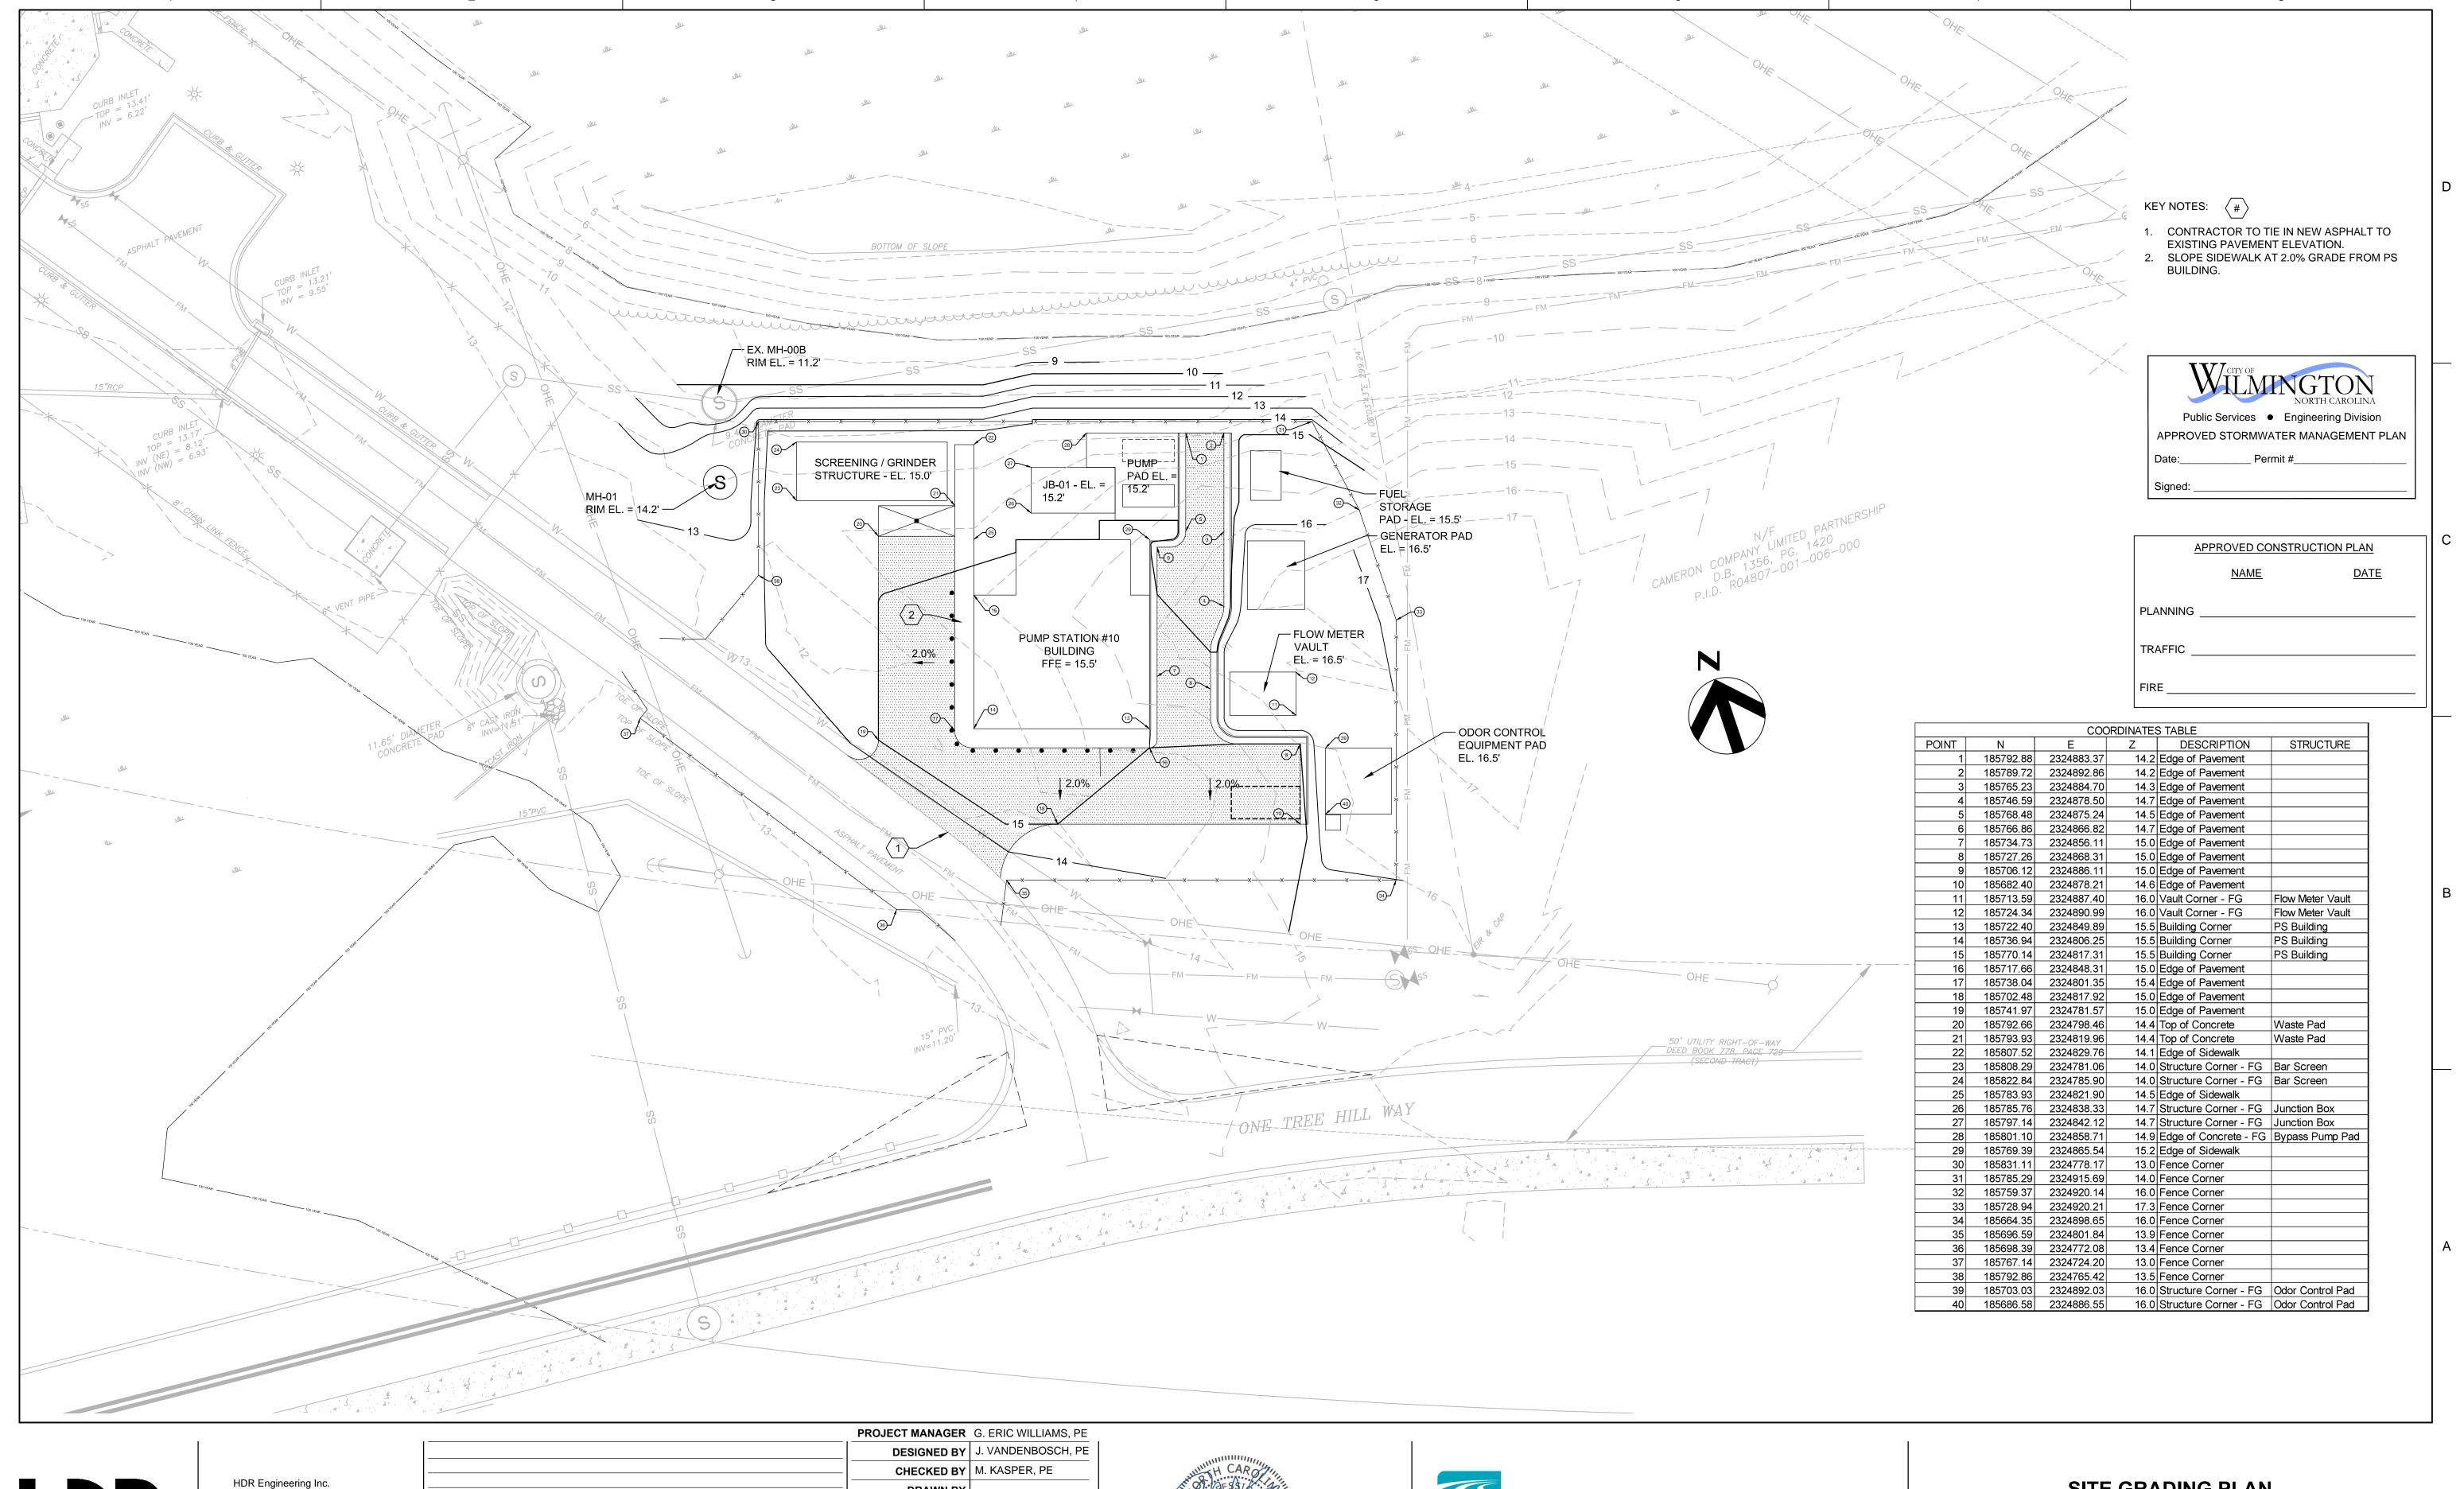



HDR Engineering Inc. of the Carolinas NC BELS License # F-0116 101 N. Third Street Wilmington NC, 28401 910-398-9020

			DESIGNED BY	J. VANDENBOSCH, PE
			CHECKED BY	M. KASPER, PE
			DRAWN BY	,
0	10/2018	ISSUED FOR CONSTRUCTION		
ISSUE	DATE	DESCRIPTION	PROJECT NUMBER	100075083





PUMP STATION #10 REPLACEMENT


SITE GRADING PLAN



FILENAME 00C-02.dwg

SCALE 1" = 20'

SHEET 01C-02

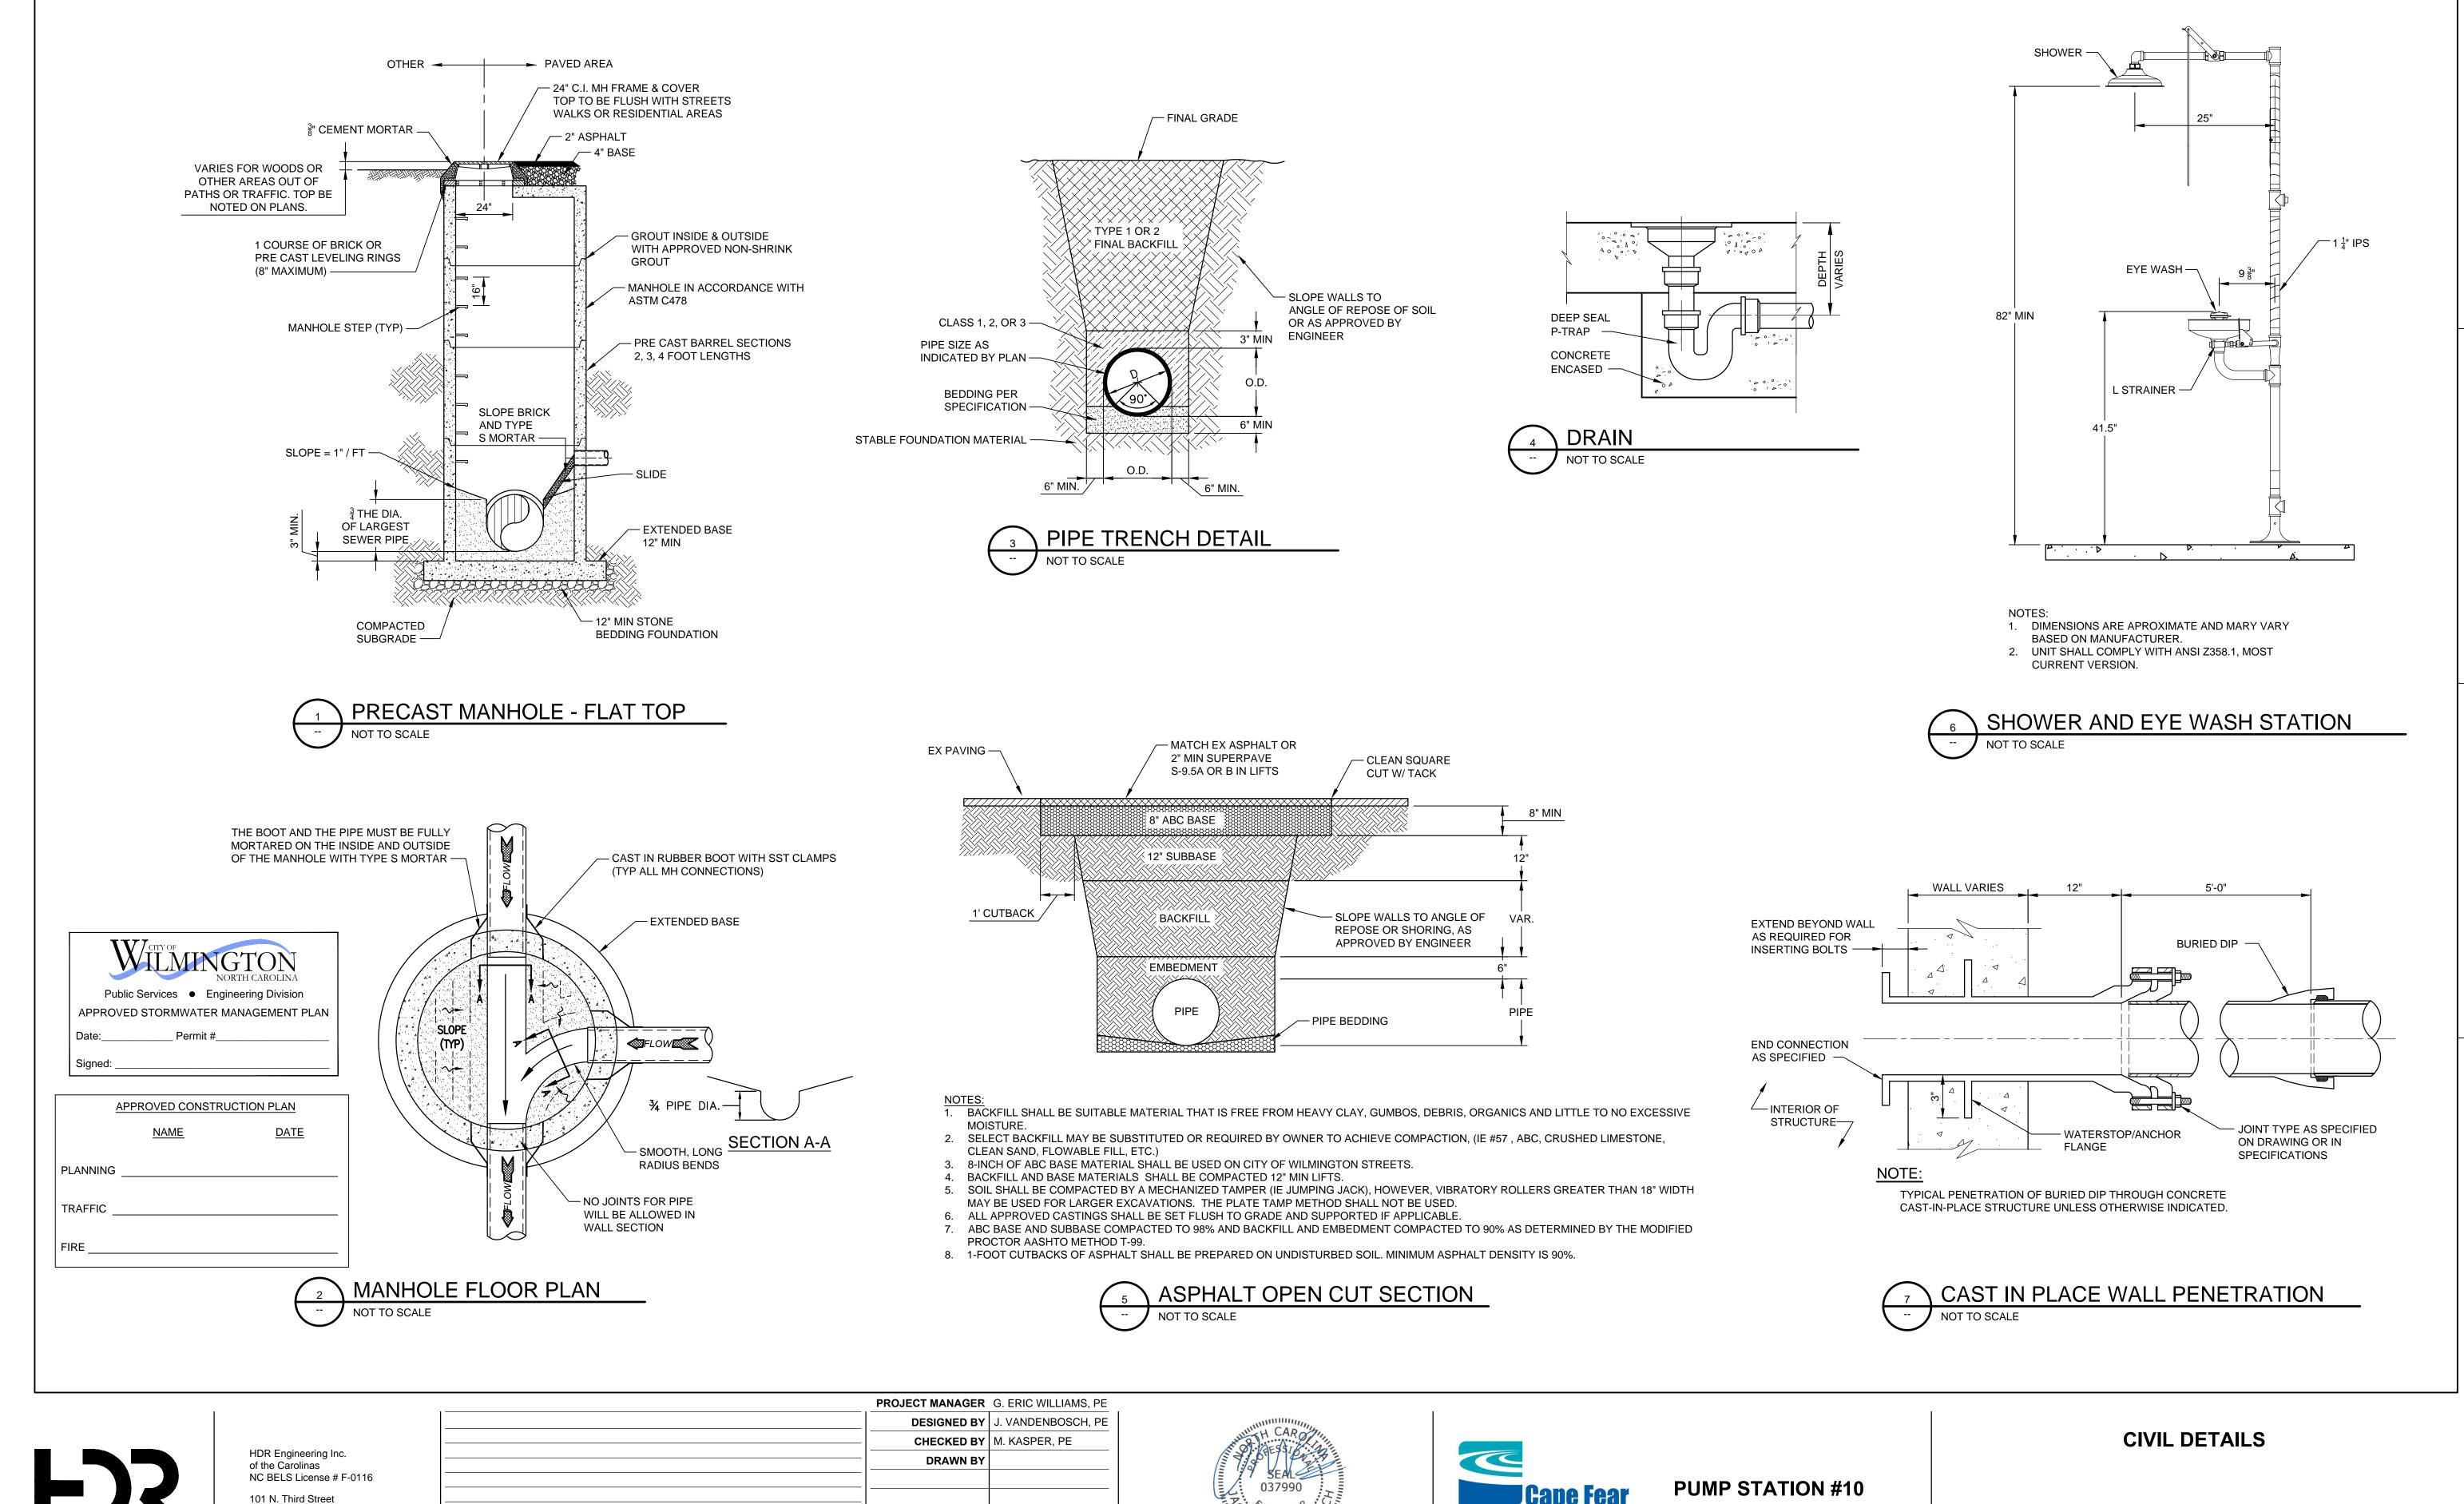

910-398-9020


Wilmington NC, 28401 ISSUED FOR CONSTRUCTION DATE DESCRIPTION PROJECT NUMBER | 100075083





REPLACEMENT

SHEET FILENAME 99C-01.dwg 99C-01 **SCALE** 1/4" = 1'0"

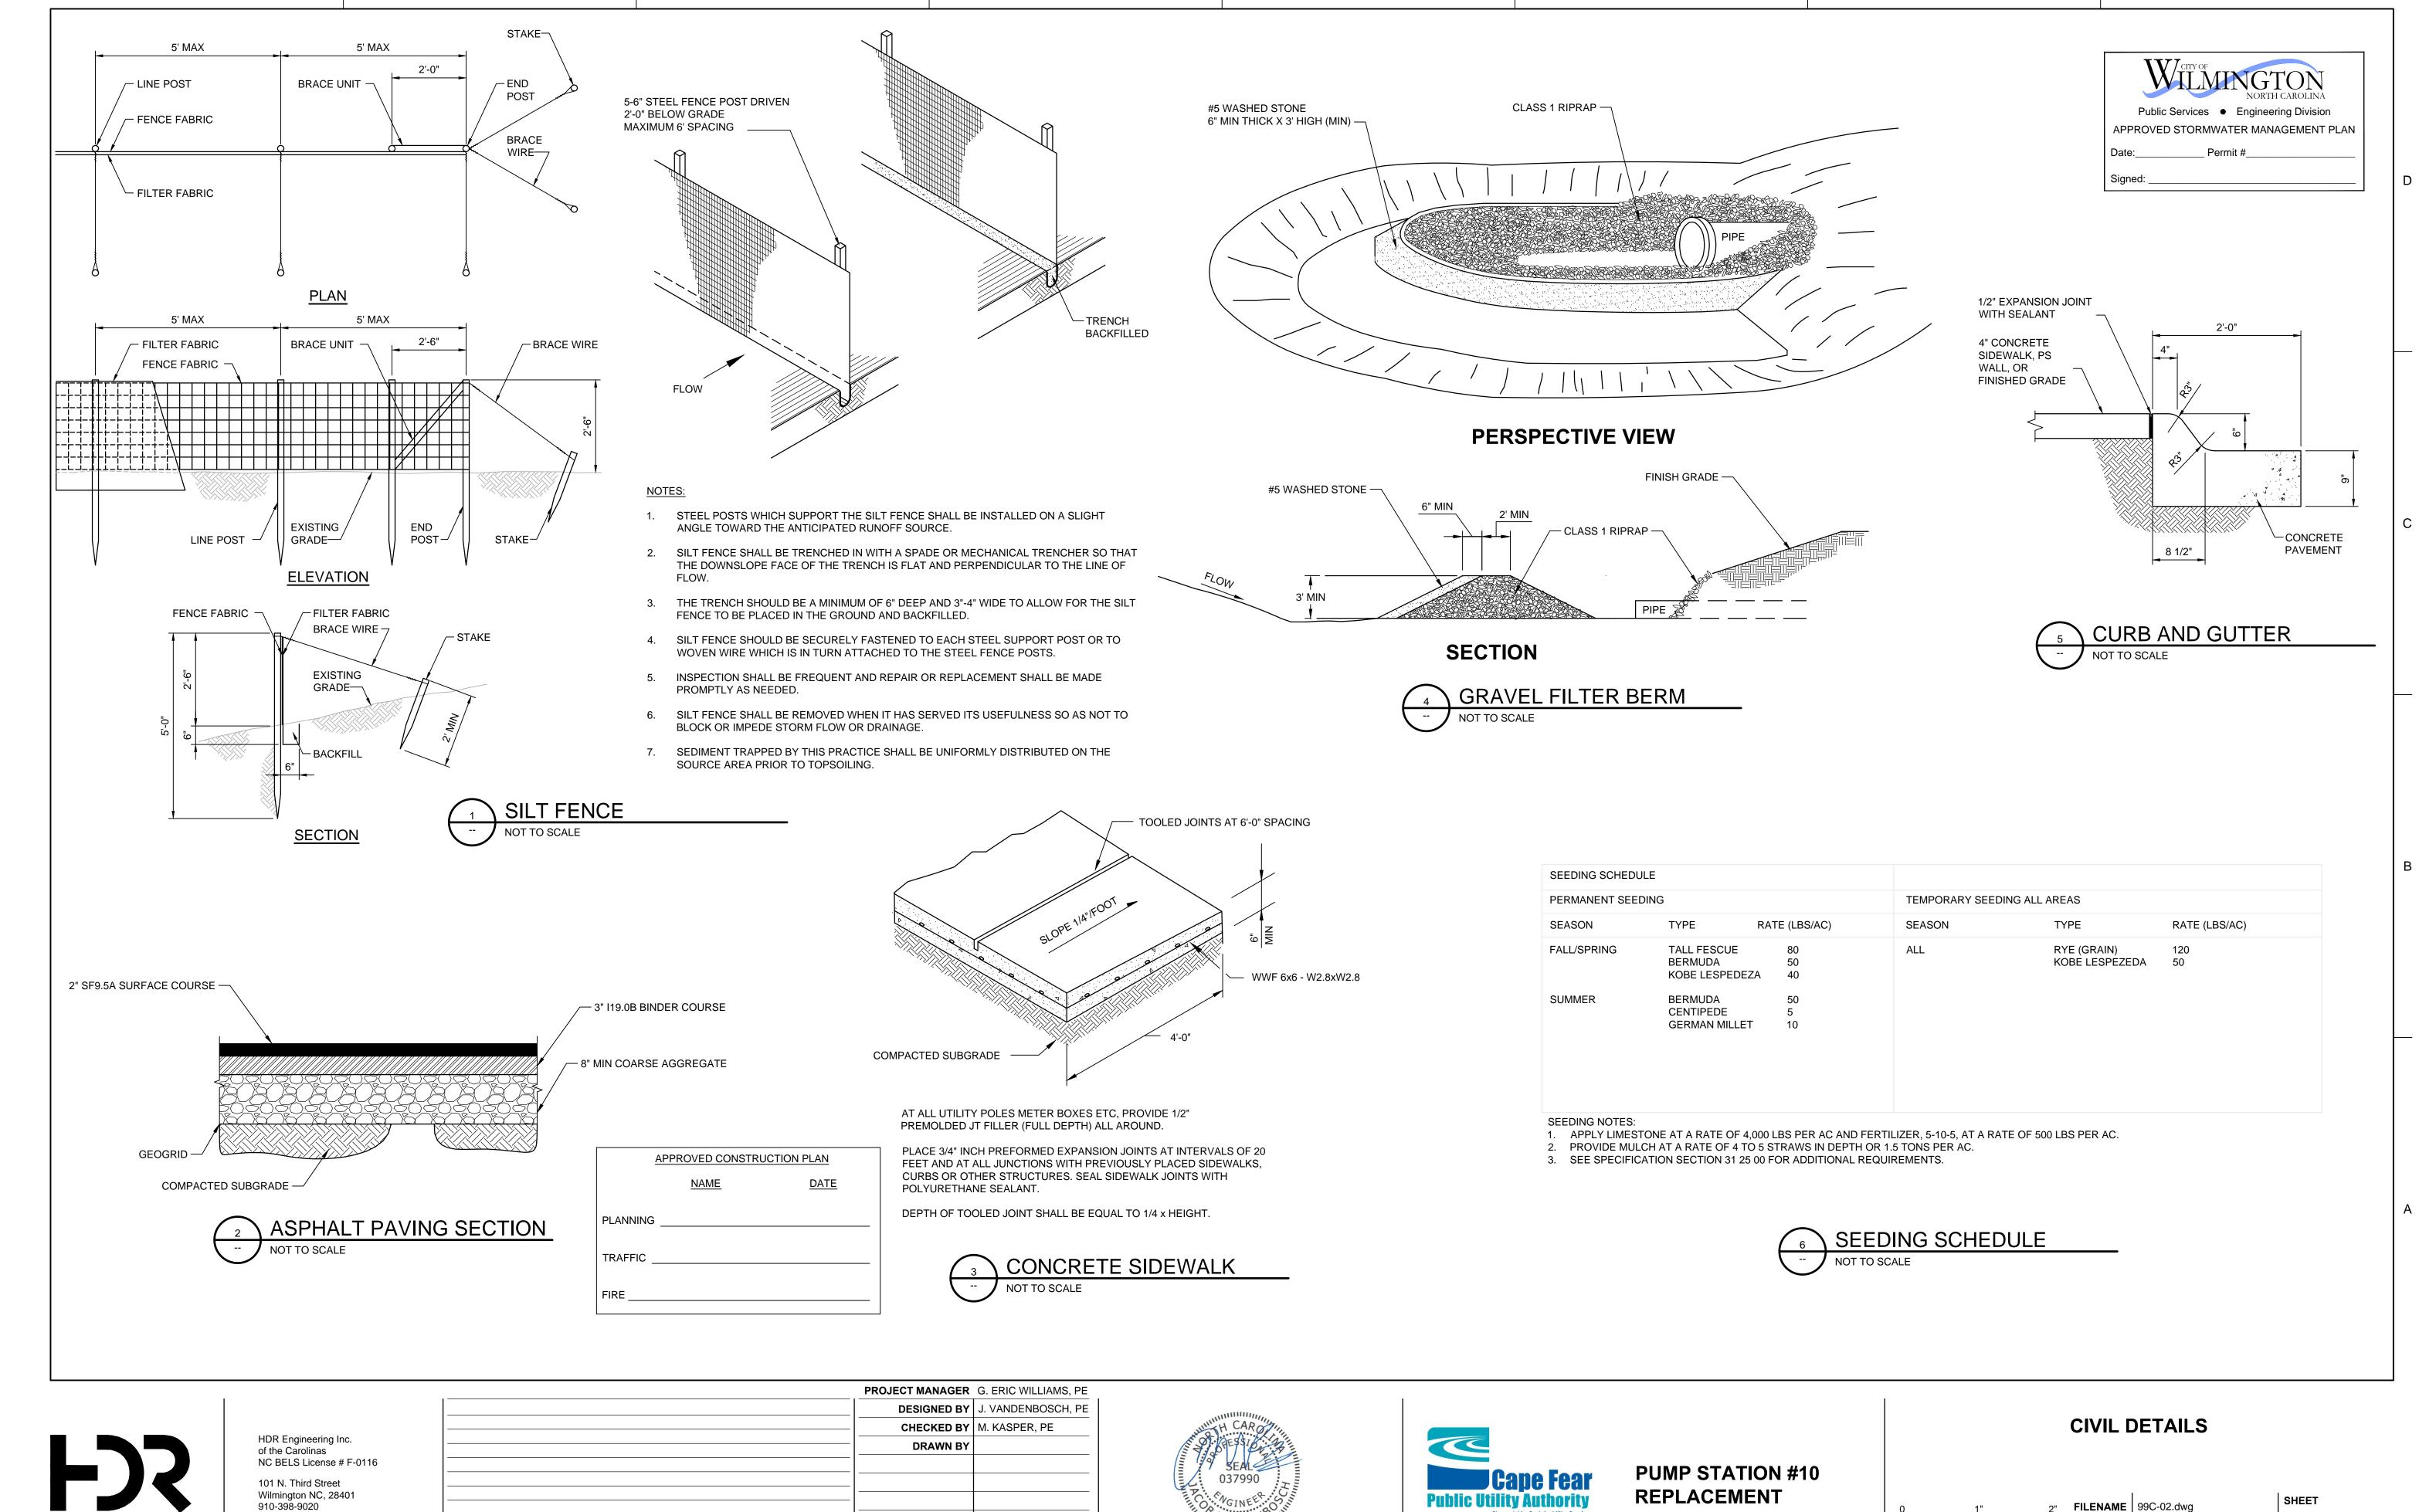

ISSUED FOR CONSTRUCTION


PROJECT NUMBER | 100075083

DESCRIPTION

DATE

99C-02


SCALE 1/4" = 1'0"

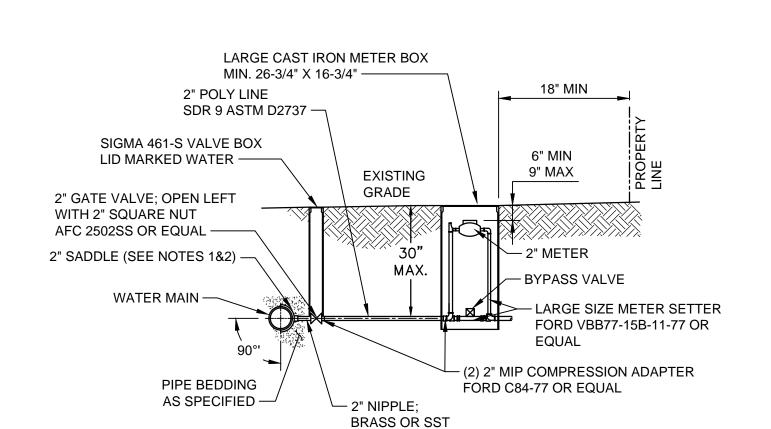

NOTES:

- 1. ALL SERVICES SHALL BE INSTALLED PERPENDICULAR TO MAIN.
- 2. SERVICE SADDLES ON PVC MAINS SHALL BE WIDE BAND BRASS BODY: MCDONALD 3800, FORD S90 (DOUBLE STRAP) OR EQUAL.
- 3. METER BOXES SHALL CONFORM TO ASTM A48, CLASS 30B, AND AASHTO H20 LOADING STANDARDS (OLDCASTLE PRECAST MODEL B1730 OR EQUAL).
- 4. 3" CLEAN FILL REQUIRED ALL AROUND 2" POLY SERVICE LINE.



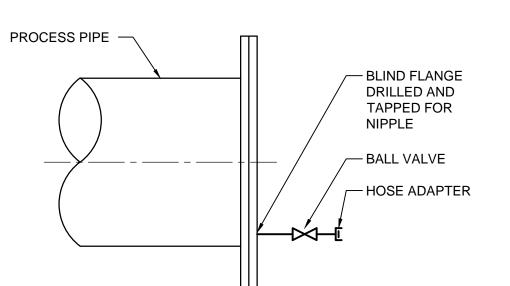

NOTES:

HDR Engineering Inc.

NC BELS License # F-0116

of the Carolinas


101 N. Third Street

910-398-9020


Wilmington NC, 28401

- USE TAPPING SADDLE OR WELDED BOSS FOR PIPE LESS
 THAN 6" DIAMETER OR WHEN REQUIRED BY PIPE WALL
 THICKNESS. USE TAPPING SADDLE ON ALL NON-METALLIC
 PIPE.
- 2. PROVIDE 2-INCH FLUSHING CONNECTION.



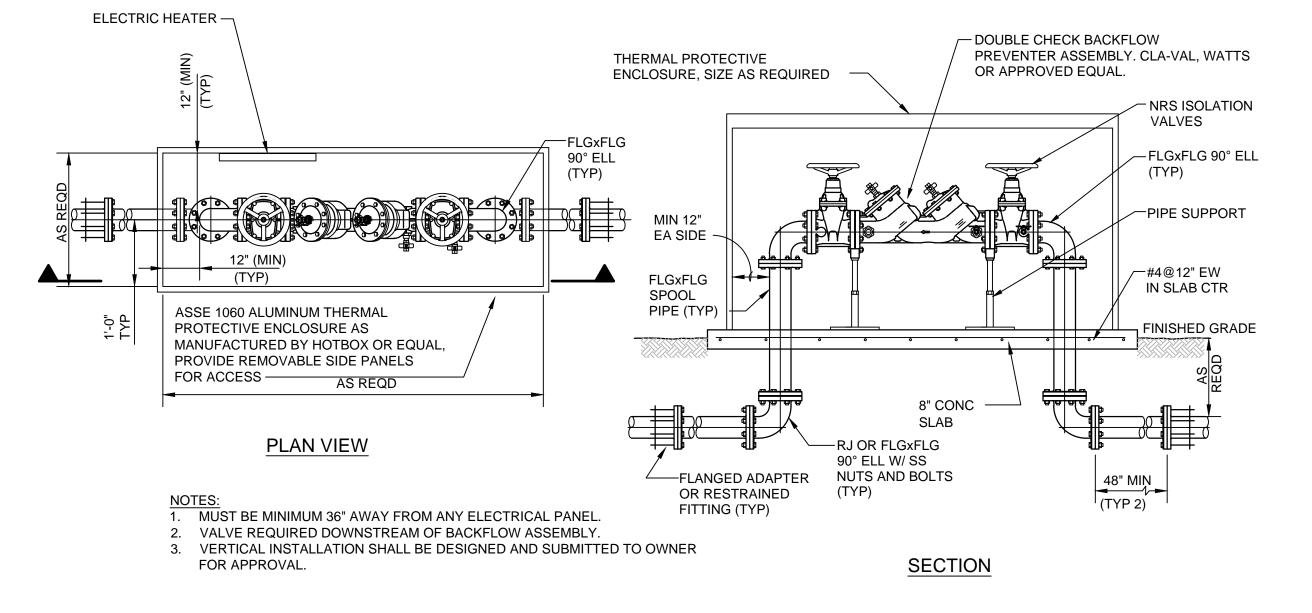




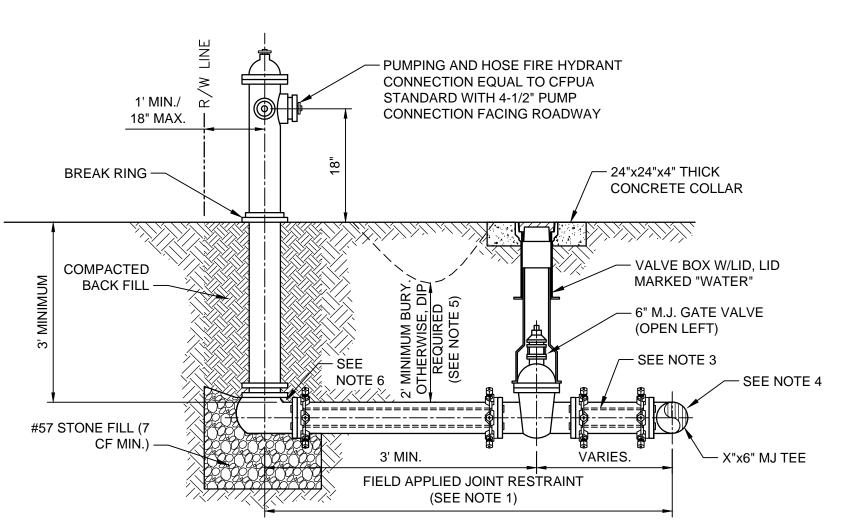


NOTES:


HARNESS AND FASTENERS.

- 1. JOINT RESTRAINT SYSTEMS SHALL BE WEDGE ACTION STYLE FOR DI OR C-900 PVC PIPE AS MANUFACTURED BY EBAA IRON, SIGMA, STAR PIPE PRODUCTS OR APPROVED EQUAL.
- 2. WHEN HYDRANT LEGS REQUIRE FULL LENGTH PIPE SECTIONS, OVER BELL RESTRAINT SYSTEM SHALL HAVE 316 STAINLESS STEEL
- 3. CONTINUOUS 316 STAINLESS STEEL RODS (TEE TO VALVE AND VALVE TO HYDRANT) MAY BE USED WITH COR-BLUE MJ T-BOLT AND GASKET KITS, AS AN ALTERNATIVE.
- 4. HYDRANT TEE SHALL BE RESTRAINED ON EACH SIDE OF MAIN PLUS ANY VALVE, FITTING, OR JOINT IN MAIN WITHIN 10-FEET OF
- 5. HYDRANT AND VALVE SHALL BE PLACED OUTSIDE DITCH LIMITS.6. WEEP HOLES OPEN AND UNBLOCKED TO DRAIN.

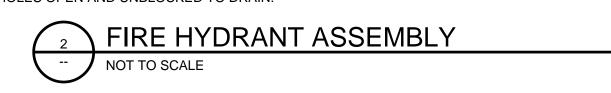

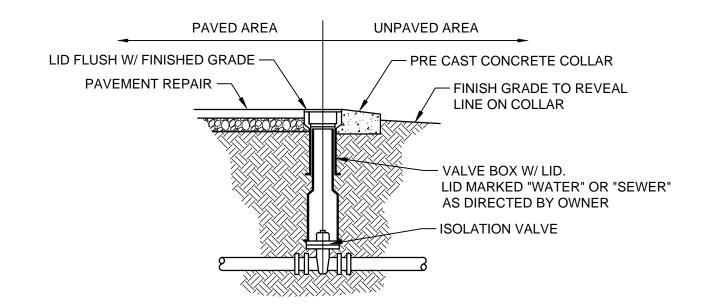



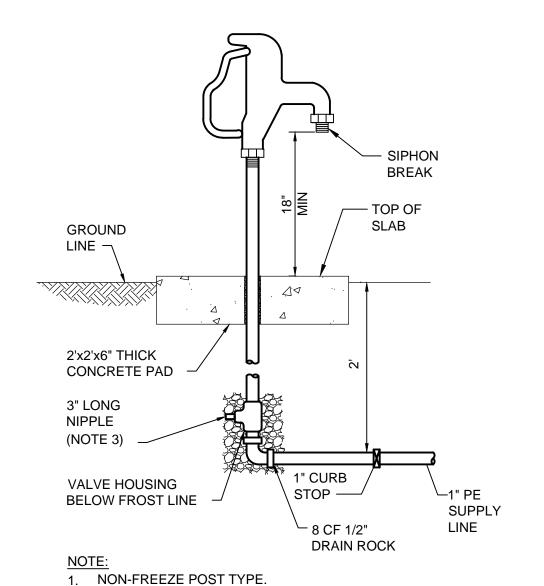

- 2. HOSE BIBB SHALL ACCOMODATE STANDARD 3/4" GARDEN HOSE.
- MATCH DRAIN PORT SIZE PROVIDED BY MANUFACTURER.



-3

Public Services • Engineering Division

APPROVED STORMWATER MANAGEMENT PLAN

APPROVED CONSTRUCTION PLAN

PLANNING

TRAFFIC





PUMP STATION #10 REPLACEMENT ı

CIVIL DETAILS

FILENAME 99C-03.dwg

SCALE 1/4" = 1'0"

99C-03

FILLED EXPANSION JOINT


CONTROL JOINT

SECTION B-B

WILMINGTON

SD 3-10

CITY OF WILMINGTON ENGINEERING PO BOX 1810 WILMINGTON N.C. 28402 (910) 341-7807

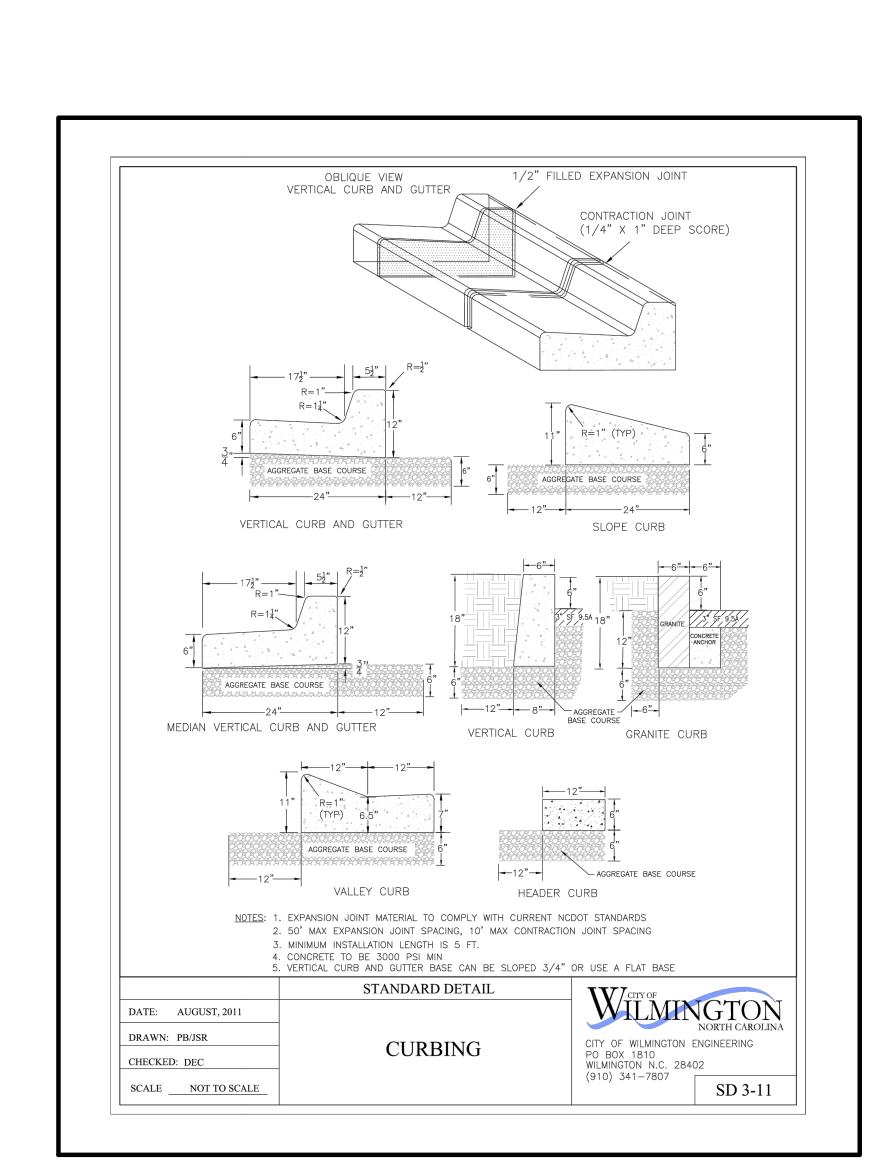

Public Services

Engineering Division APPROVED STORMWATER MANAGEMENT PLAN _ Permit #___

<u> </u>	APPROVED CONSTRUCTION PLAN			
	NAME	<u>DATE</u>		
PLANNING				
TRAFFIC _				
FIRE				

FILLED EXPANSION JOINT

DATE: OCTOBER, 2010

SCALE NOT TO SCALE

HDR Engineering Inc.

NC BELS License # F-0116

of the Carolinas

101 N. Third Street

910-398-9020

Wilmington NC, 28401

DRAWN: PB/JSR

CHECKED: DEC

FILLED EXPANSION JOINT

SECTION A-A

NOTES: 1. JOINT MATERIAL TO COMPLY WITH CURRENT NCDOT STANDARDS.

LOCATED OUTSIDE SIDEWALK WHERE FEASIBLE.

APRON) SHALL BE CLASS "A" - 3,000 PSI.

5. MINIMUM REPLACEMENT FOR REPAIRS IS A 5' X 5' PANEL

7. MINIMUM DEPTH FOR TUNNELING BELOW SIDEWALK IS 12"

8. MAX ADJACENT GROUND SLOPE WITHOUT RAILING IS 2:1

THE SLOPE OF THE EXISTING ADJACENT ROAD.

6. 4" STONE BASE MAY BE REQUIRED FOR POOR SOIL CONDITIONS

STANDARD DETAIL


SIDEWALK

2. SANITARY SEWER CLEAN-OUTS, WATER METERS, MANHOLES, AND VALVE LIDS TO BE

4. CONCRETE FOR ALL SIDEWALKS (EXCEPT ANY PORTION CONTAIN WITHIN A DRIVEWAY

9. MIN GRADE FOR PROPER DRAINAGE IS 1% IN AT LEAST 1 DIRECTION. MAX CROSS SLOPE IS 2%. MAX LONGITUDINAL SLOPE IS 8.3%, 10% IF LIMITED BY EXISTING CONDITIONS, OR NO GREATER THAN

3. MINIMUM SIDEWALK WIDTH TO BE 6' MINIMUM IF PLACED AT BACK OF CURB.

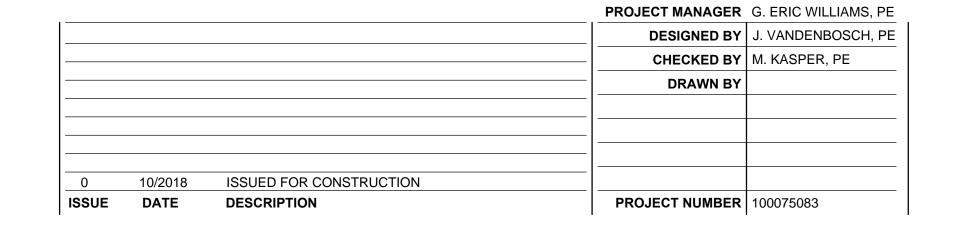









CIVIL DETAILS

